



Property Boundary





FVP Hialeah 21 Acres, LLC  
 MIAMI-DADE COUNTY, FLORIDA



RS Environmental Consulting Inc  
 P.O. Box 131133  
 Miami FL 33116  
 Phone 305-333-3414  
 Fax 305-333-3273  
[www.rs-env.com](http://www.rs-env.com)

Vicinity Map  
 T-52S R-45E S-20

DRAWN BY: LVK	DATE: 7/7/2014
CHECKED BY: RWS	SCALE: As Shown

 Property Boundary - 20.24 AC  
 6410 - Freshwater Marshes / Graminoid Prairie - Marsh - 4.98 AC







**Flightway Fourteen, LLC**  
 MIAMI-DADE COUNTY, FLORIDA




RS Environmental Consulting Inc.  
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2012 Aerial  
**Revised Vegetation Map**  
 T-52S, R-40E, S-20  

DRAWN BY: LVK	DATE: 1/4/2017
CHECKED BY: RWS	SCALE: As Shown

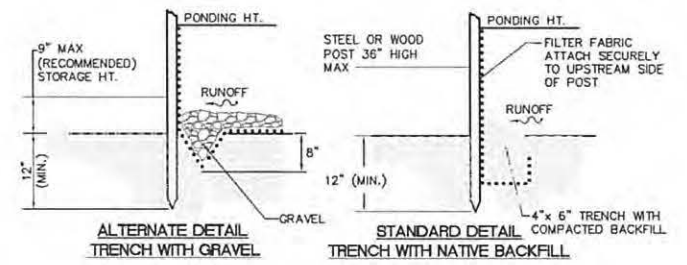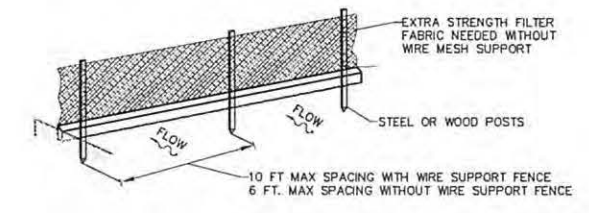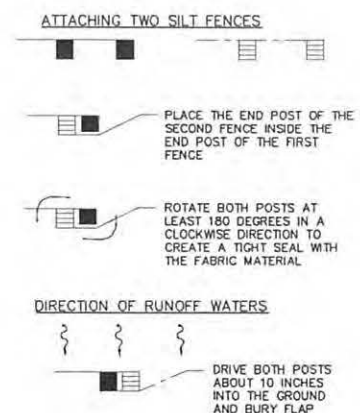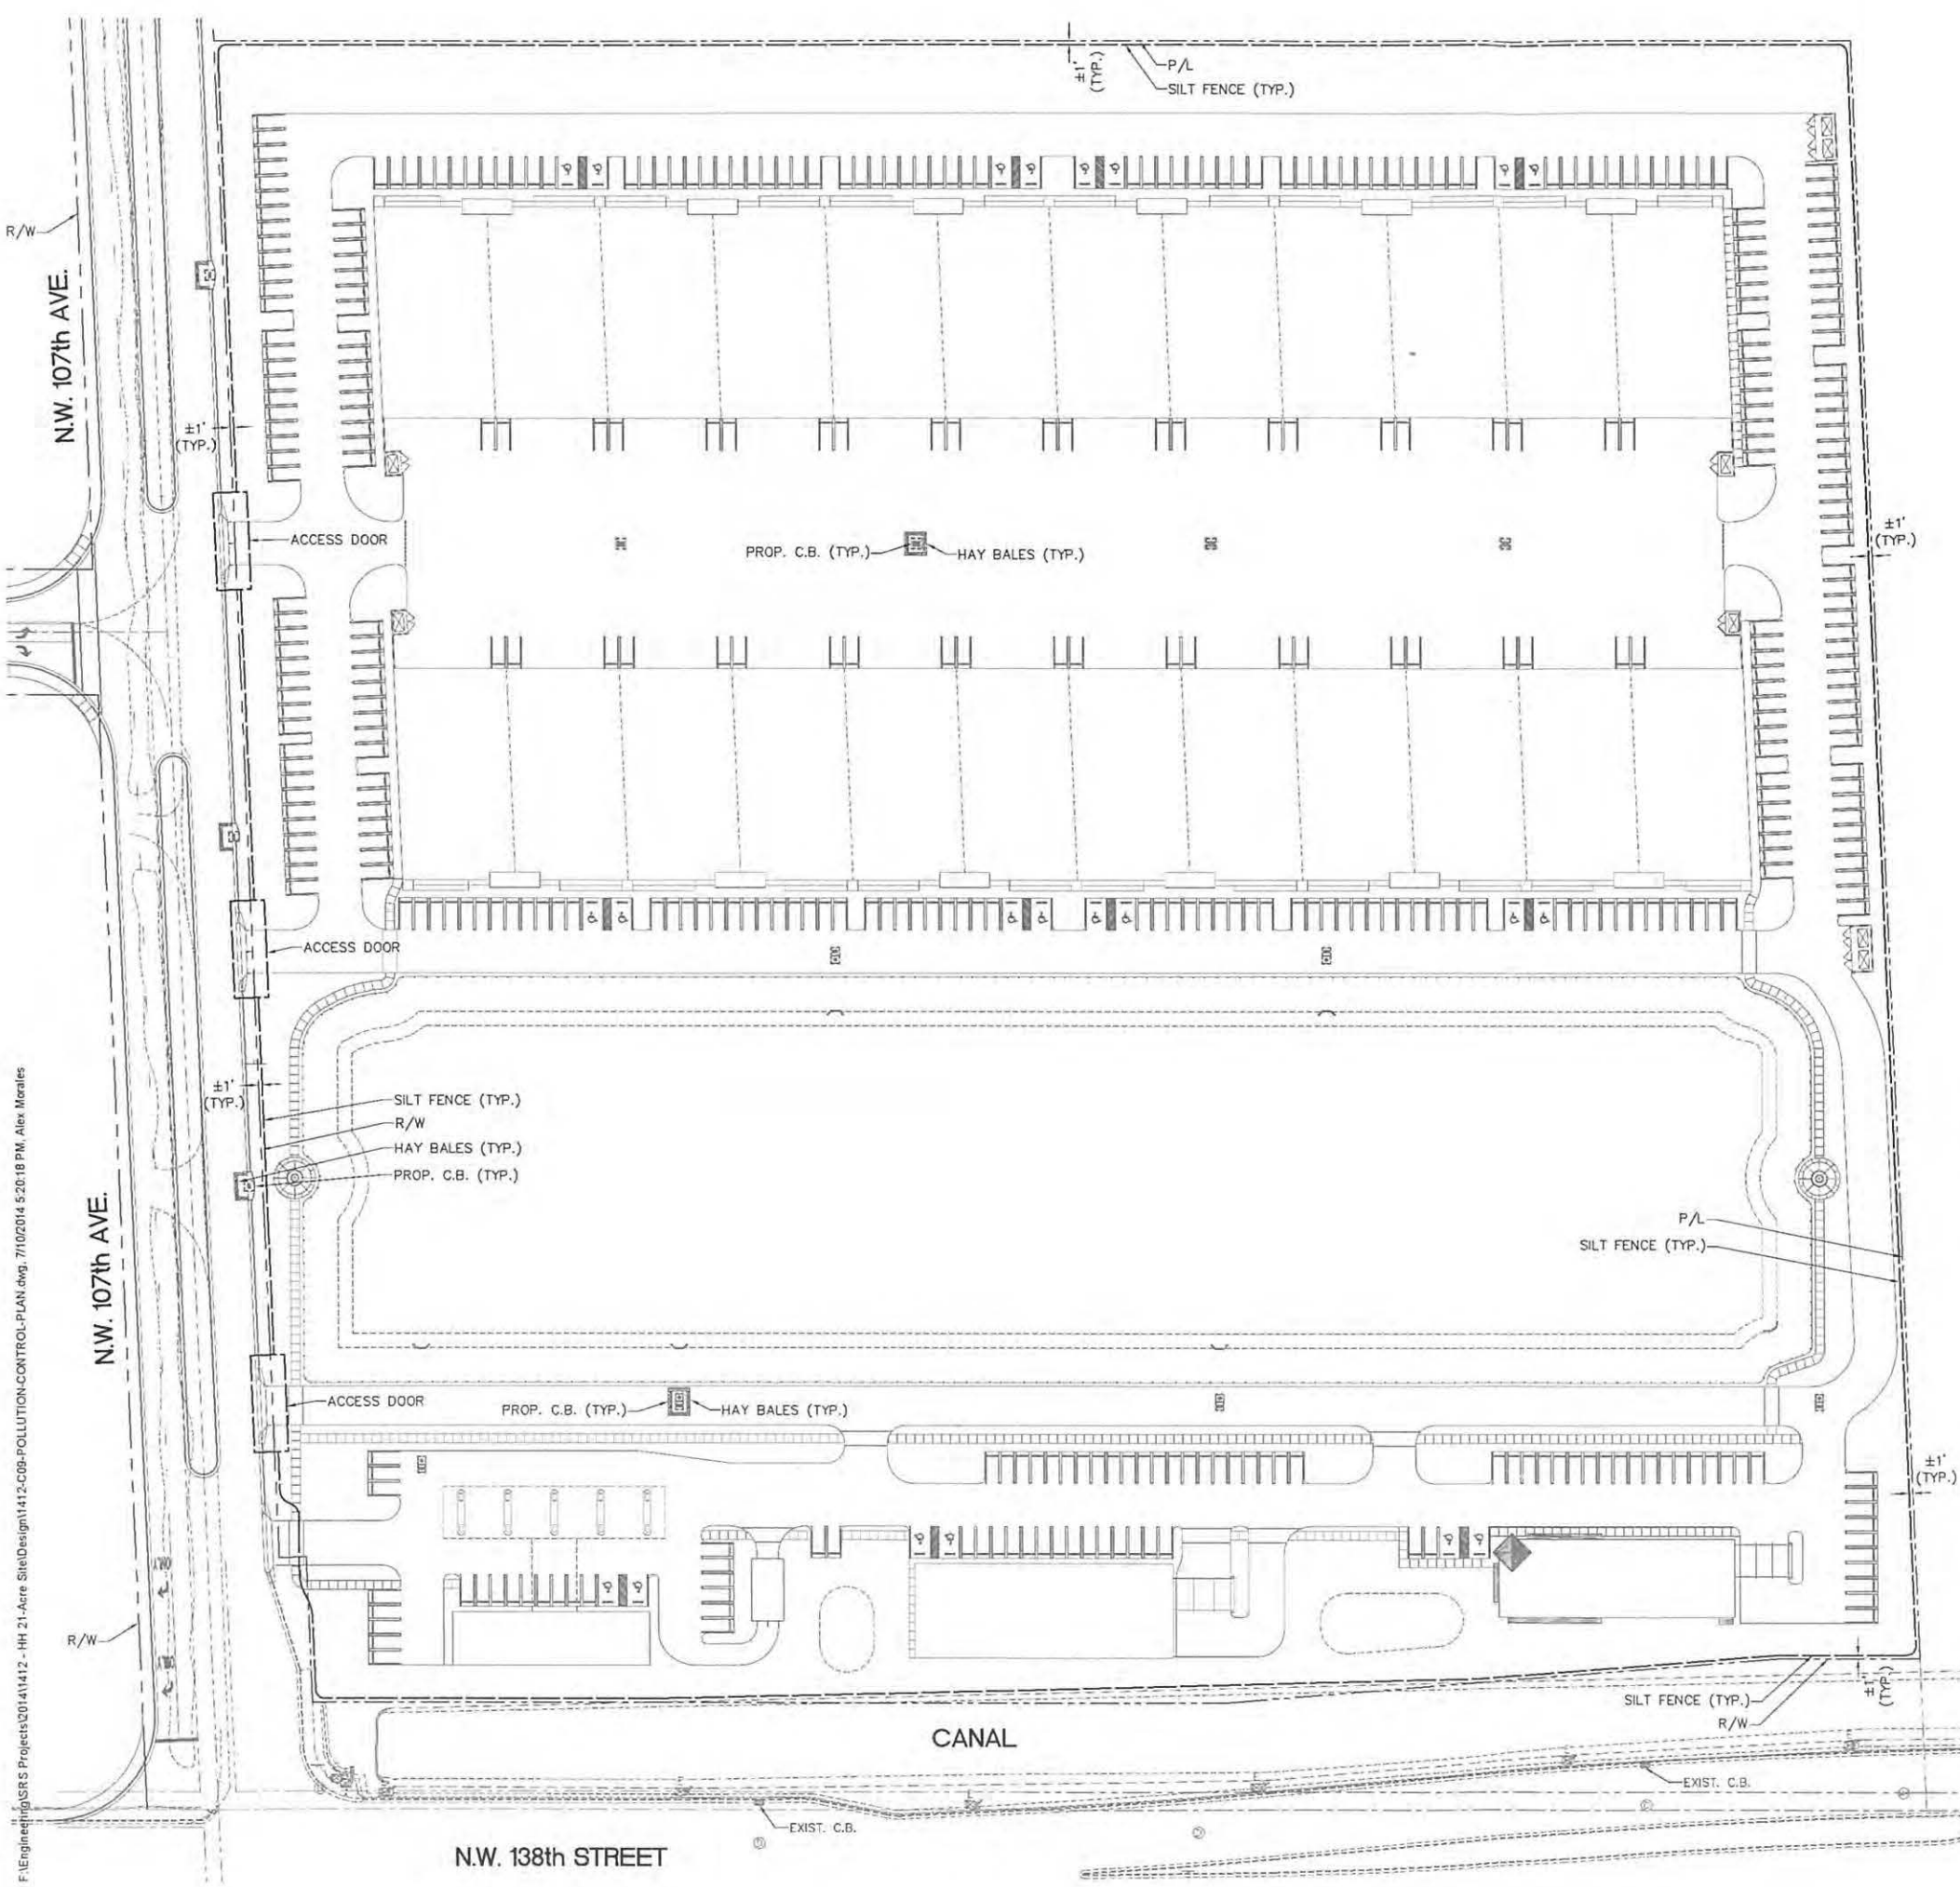


**TEMPORARY EROSION AND TURBIDITY CONTROL DETAILS**  
N.T.S.

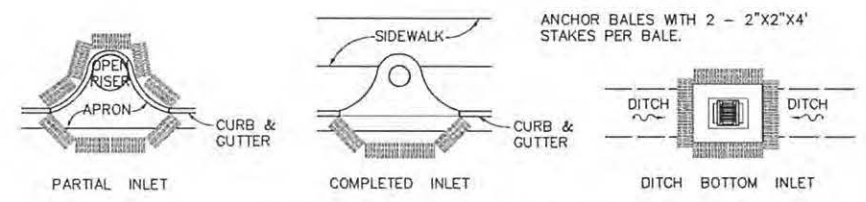

**PROTECTION AROUND INLETS OR SIMILAR STRUCTURES**  
N.T.S.

**GENERAL NOTES:**

- TEMPORARY EROSION AND TURBIDITY CONTROL SHALL BE IMPLEMENTED PRIOR TO AND DURING CONSTRUCTION, AND PERMANENT CONTROL MEASURES SHALL BE COMPLETED WITHIN 7 DAYS OF ANY CONSTRUCTION ACTIVITY.
- TURBIDITY BARRIERS AND/OR BALED HAY OR STRAW BARRIERS AND SILT FENCES SHALL BE INSTALLED AND MAINTAINED AT ALL LOCATIONS AS INDICATED ON PLANS. TURBIDITY BARRIERS AND/OR BALED HAY OR STRAW BARRIERS AND SILT FENCES SHALL REMAIN IN PLACE IN ALL LOCATIONS UNTIL CONSTRUCTION IS COMPLETED AND SOILS ARE STABILIZED AND VEGETATION HAS BEEN ESTABLISHED.
- HAY BALES SHALL BE TRENCHED 3" TO 4" AND ANCHORED WITH 2 - 1" x 2" (OR 1" DIAM.) x 4" WOOD STAKES. STAKES OF OTHER MATERIAL OR SHAPE PROVIDING EQUIVALENT STRENGTH MAY BE USED IF APPROVED BY THE ENGINEER.
- ADJACENT BALES SHALL BE BUTTED FIRMLY TOGETHER. UNAVOIDABLE GAPS SHALL BE PLUGGED WITH HAY OR STRAW TO PREVENT SILT FROM PASSING.
- SILT FENCES SHALL BE INSTALLED AS INDICATED ON PLANS.
- HAY BALES & FILTER FABRIC SHALL BE INSTALLED AT ALL NEW INLETS DURING CONSTRUCTION.
- HAY BALES & FILTER FABRIC SHALL BE INSTALLED AT EXISTING INLETS LOCATED IN SWALE AREA.
- SILT FENCES SHALL BE PROVIDED ON EXIST INLETS LOCATED IN C&G, OR VALLEY GUTTER.
- FOR ADDITIONAL STRENGTH FILTER FABRIC MATERIAL CAN BE ATTACHED TO A 6" (MAX.) MESH WIRE SCREEN WHICH HAS BEEN FASTENED TO THE POSTS.
- THE FABRIC MATERIAL AND THE WIRE MESH SHALL NOT EXTEND MORE THAN 36" (90 CM) ABOVE THE ORIGINAL GROUND SURFACE.
- SILT FENCES AND FILTER BARRIERS SHALL BE INSPECTED IMMEDIATELY AFTER EACH RAINFALL AND REMOVE SEDIMENT WHEN NECESSARY.
- REMOVE SEDIMENT SHALL BE DEPOSITED TO AN AREA THAT WILL NOT CONTRIBUTE SEDIMENT OFF-SITE AND CAN BE PERMANENTLY STABILIZED.
- SILT FENCE SHALL BE PLACED ON SLOPE CONTOURS TO MAXIMIZE PONDING EFFICIENCY.

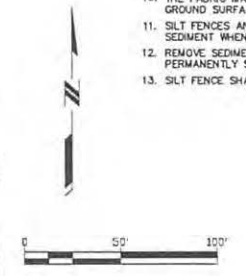

**LEGEND:**

	HAY BALES (TEMP. EROSION CONTROL)
	SILT FENCE, FDOT TYPE III (TEMP. EROSION CONTROL)

PROJECT No. 1412  
DRAWN BY: [Signature]  
CHECKED BY: [Signature]  
DATE: 07/10/2014  
STATE OF FLORIDA  
PROFESSIONAL ENGINEER  
No 44771  
STORM WATER POLLUTION PREVENTION PLAN AND DETAILS  
C-9  
SHEET 10 OF 10

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